


## PROPOSED LAYOUT 1:200

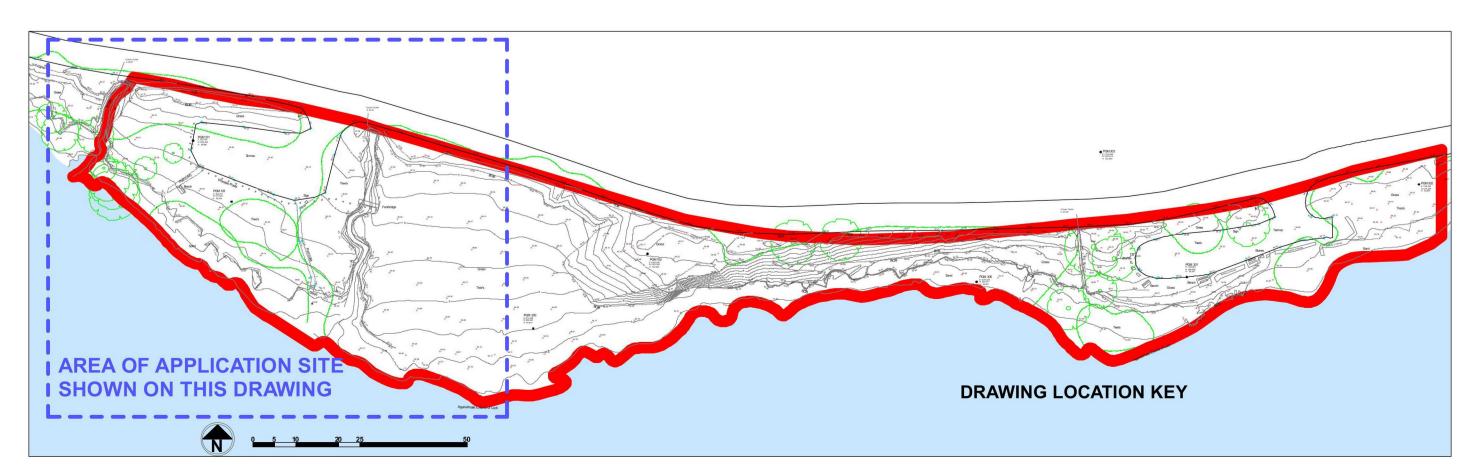

DRAWING LOCATION KEY



### **EXISTING LAYOUT 1:500**

#### Native Tree and Shrub Planting for dry ground and slopes:

Species varied according to exact site conditions

Stock of native provenance to be used where possible

Transplants to be notch planted into existing topsoil.

Feathered trees to be pit planted into mix of existing and imported topsoil.

Spacing to be increased to 2 -3m<sup>2</sup> where underplanting existing woodland (depending on existing tree and shrub layer)

For bare or disturbed ground planting to be undersown with species rich grass mix, leaving radius of approx. 250mm unsown around each plant. When underplanting, existing vegetation is to be retained (except circle radius 250-500mm round each tree) and gaps made good with Woodland Meadow mix (amended according to shade level)

% of mix	Species	Size at planting	Density
10	Prunus avium (Gean)	Feathered, 125- 150cm high, 2x transplanted, bare root	1 per m²
20	Quercus petraea (Sessile Oak)	Feathered, 125- 150cm high, 2x transplanted, bare root	1 per m²
10	Sorbus aucuparia (Rowan)	Feathered, 125- 150cm high, 2x transplanted, bare root	1 per m²
15	Betula pendula (Silver Birch)	CG, 2L, 40-60cm high	1 per m²
10	Corylus avellana (Hazel)	1+2 transplant, 40-60cm high	1 per m²
5	Lonicera periclymenum (Honeysuckle)	1+2 transplant, 40-60cm high	1 per m²
5	Crataegus monogyna (hawthorn)	1+2 transplant, 40-60cm high	1 per m²
5	Sambucus nigra (Elder)	1+2 transplant, 40-60cm high	1 per m²
5	Ulmus glabra (Wych Elm)	1+2 transplant, 40-60cm high	1 per m²
5	llex aquifolium (Holly)	CG, 2L, 40-60cm high	1 per m²
5	Pinus sylvestris (Scots Pine)	CG, 2L, 40-60cm high	1 per m²
5	Rosa canina (Dog Rose)	1+2 transplant,	1 per m²

# NOTES:

- Soil from excavation to be retained and reused

All feathered trees to have single stake and tree shelter. Tree shelter to be 1.2m high, green in colour, with a stake.
All shrubs to have shrub shelter. Shrub shelters to be 0.6m high, green in colour,

40-60cm high

with a stake.

Stock of native provenance to be used where possibleAll feathered trees to be pit planted into existing soil with imported soil where

necessary to make up depth. Mulch with chipped brash from on site to 30mm deep, radius 250mm around each tree. Tree pit size 600x600x600mm.

- All smaller stock to be notch planted into existing ground. Turn over existing soil, notch plant and mulch with chipped brash from on site to 30mm deep, radius 250mm around each plant.

- Mix to be planted at varied spacing of approx. 1 plant per m², in random layout with no straight lines visible (see diagram)

Where planting on bare ground the planting mix to be undersown with Woodland Meadow Mix or Wet Meadow Mix (from Scotia Seeds, tel 01356 626425), sown at 3g/m², leaving a radius of 250mm unsown around each plant, and mulched with chipped brash.
Where planting beneath existing woodland vegetation the spacing is increased to

1 plant per 2m², and any bare ground to be undersown with Woodland Meadow Mix or Wet Meadow Mix, sown at 3g/m², leaving a radius of 250mm unsown around each plant, and mulched with chipped brash.

Where planting into existing ground vegetation, clear the ground cover by radius
250mm and mulch to 30mm deep using chipped brash from on site.
Amenity grass seed - eg. British Seed Houses mix A22 'Low Maintenance', sown

at 35g/m2, on min. 50mm topsoil
- Species rich mixes - Woodland Meadow Mix and Wet Meadow Mix (from Scotia Seeds, tel 01356 626425), sown at 3g/m², can be sown on subsoil or poor quality

#### Native Shrub Planting:

Stock of native provenance to be used where possible

Species varied according to exact site conditions

Transplants to be notch planted into existing topsoil. Spacing to be increased to 2 -3m<sup>2</sup> where underplanting existing woodland (depending on existing tree and shrub layer)

For bare or disturbed ground planting to be undersown with species rich grass mix, leaving radius of approx. 250mm unsown around each plant. When underplanting, existing vegetation is to be retained (except circle radius 250-500mm round each tree) and gaps made good with Woodland Meadow mix (amended according to shade level)

% of mix	Species	Size at planting	Density
20	Corylus avellana (Hazel)	1+2 transplant, 40-60cm high	1 per m²
20	Crataegus monogyna (Hawthorn)	1+2 transplant, 40-60cm high	1 per m²
10	Prunus spinosa (Blackthorn)	1+2 transplant, 40-60cm high	1 per m²
5	Lonicera periclymenum (Honeysuckle)	1+2 transplant, 40-60cm high	1 per m²
10	Sambucus nigra (Elder)	1+2 transplant, 40-60cm high	1 per m²
10	Viburnum opulus (Guelder Rose)	1+2 transplant, 40-60cm high	1 per m²
5	Salix aurita (Eared willow)	1+2 transplant, 40-60cm high	1 per m²
10	Ulex europaea (Gorse)*	1+2 transplant, 40-60cm high	1 per m²
10	Cytisus scoparius (Broom)*	1+2 transplant, 40-60cm high	1 per m²

\*At edges only

Random planting layout to be used

Revision Summary a - note correc•on

Project Title: 5 Lochs Phase 2

Loch Venachar North

Drawing Title: Exis•ng and Proposed Site Plans

Drawing No: 1VN DL 003

Drawing No: LVN\_PL\_003
Stage: Planning

Scale: As shown

Date: Oct 2014

Revision: a

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